30' x 120'
Headline Mining
Dredge



















- Hull consisting of 8 each Pre-Fabricated Compartments with Suction Ladder Assembly
  - Approximately 7' Wide in various lengths with 4 sections being 30' Long and 4 sections being 38' Long










- Slurry Pump 1 each Warman 16" x 14" Slurry Pump
  - Pumping an estimated 9,000 GPM at an estimated 92' of total head, 50' total elevation and a discharge pipe of 14"










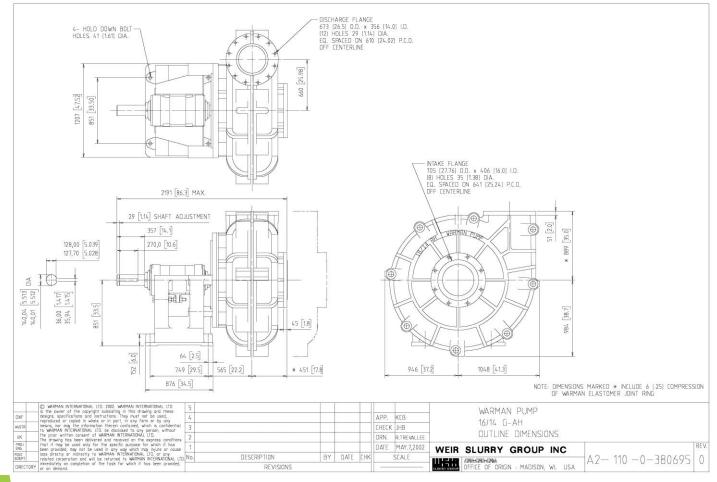

Warman® AH®, AHP and AHPP slurry pump - outline dimensions

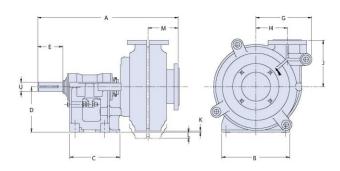

Pump Size	Α	В	С	D	U	Key Size	Ε	G	н	J	К	L	M		nate mass g)
Marin Control Control	mm	mm	mm	mm	mm	mm	mm	mm	mm	mm	mm	mm	mm	metal	rubber
1.5/1 BAH	583	295	248	197	28	8X7	79	181	98	171	46	-	106	90	75
2/1.5 BAH	596	295	248	197	28	8X7	79	203	114	184	33	-	115	100	85
3/2 CAH	777	406	311	254	42	12X8	122	238	138	210	67	-	156	200	160
4/3 CAH	848	406	311	264	42	12X8	121	292	149	262	20	%	192	300	230
4/3 DAH	948	492	364	330	65	18X11	152	292	149	262	100	-	192	380	280
6/4 DAH	1028	492	364	330	65	18X11	150	406	229	338	12		228	660	420
6/4 EAH	1188	622	448	457	80	22X14	220	406	229	338	139		228	810	620
6/4 EEAHP	1240	622	448	457	85	22X14	222	435	229	460	49		230	1110	980
8/6 EAH	1318	622	448	457	80	22X14	222	551	318	460	-	62	292	1510	980
8/6 FAH	1518	857	635	610	100	28X16	279	551	318	460	91		304	1650	1160
8/6 FFAHPP	1569	857	635	610	120	32X18	290	615	318	615	16	-	304	2920	2480
10/8 FAH	1650	990	705	610	100	28X16	279	667	419	635		12	334	2650	1970
10/8 STAH	1753	1150	780	650	120	32X18	280	667	419	635	28		334	3450	3210
10/8 STAHP	1755	1150	780	650	120	32X18	280	760	419	735	-	69	334	5020	4530
10/8TAHPP	2136	1150	1040	650	150	36X20	350	760	419	735		70	334	5850	5150
12/10 FAH	1721	990	705	610	100	28X16	279	749	464	673	-	104	381	4080	3040
12/10 STAH	1827	1150	780	660	120	32X18	280	749	464	673		64	381	4470	3730
12/10 TAH	2204	1150	1040	650	150	36X20	350	749	464	673	- 21	64	381	5200	4570
*12/10 TAHP	2190	1150	1040	650	160	36X20	350	950	464	800	141	130	382	7520	6800
*12/10 TAHPP	2242	1150	1040	650	150	36X20	350	950	464	800	-	119	420	8280	7050
14/12 FAH	1777	990	705	610	100	28X16	279	944	629	832	-	264	406	5900	4180
14/12 STAH	1879	1150	780	650	120	32X18	280	944	629	832	-	224	406	6490	4870
*14/12TAHPP	2336	1150	1040	650	150	36X20	350	1100	629	930		248	485	12020	10500
16/14 TUAH	2320	1460	1050	900	150	36X20	350	1048	660	889		84	451	10560	7860
16/14TUAHPP	2424	1460	1050	900	150	36X20	350	1300	660	1035	-	140	540	16280	14470
20/18 TUAH	2475	1460	1050	900	150	36X20	350	1414	940	1230		417	580	17760	12890
*20/18TUAHP	2475	1460	1050	900	150	36X20	350	1600	940	1230	-	305	580	20450	14150
20/18TUAHPP	2475	1460	1050	900	150	36X20	350	1600	940	1230	-	305	580	23140	17230

Note: U dimensions and key sizes are in millimeters. All others are in inches.

<sup>\*</sup>These pump sizes have additional mounting feet on the casing




- Winches 4 each Pullman Winches
  - Pullmaster Model M18










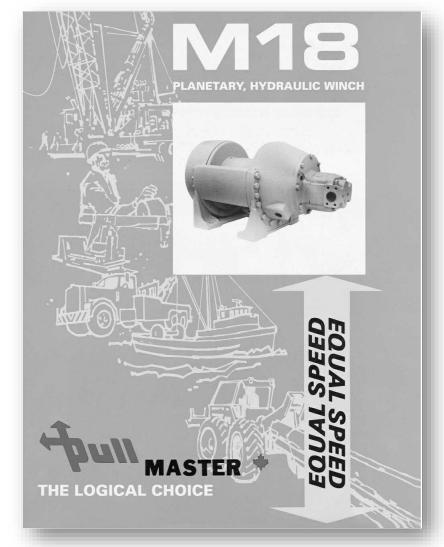

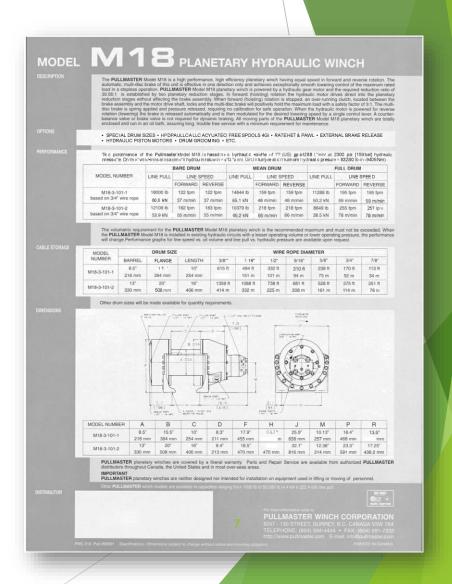



M /HS e

Planetary W inches

# MASTER Plan



#### M Series: EqualSpeed

High-perform ance, high-efficiency plane tary

winch with equalspeed in both directions. The

M ser ies offers ex cep tion ally sm ooth lowering controlofthe maximum rated load in

controlof the maximum rated load in a step less operation.

- n Hydraulic gear motor
- n Spring-applied, pressure-released, a utom atic
- m ulti-disc br ake
- n Over-running clutch enables free rotation in
- the ho isting direction without affecting the brake.
- n During low er operations, the over-running
- clutch locks causin g the disc br akes to

#### R apid R everse

High-perform ance, high-efficiency plane fary winch

with rap id reverse speed 45times faster than

forw ar d speed. In r ev erse r o tation (low e r in g), the

m axim um load can be positively controlled at a line speed equal to the ho is ting speed.

- n Hy draulic gear motor
- n Spring-applied, pressure-released multi-disc
- br ake with static andd y na micfun ctions
- n During hoisting, the hydraulic motor d
- direct into the planetary reductions w
- affecting the br ake assem bly.W hen forw ar d
- rotation is stopped, an over-running c lutch will lock and the multi-disc brake willpos

M Series				qualSpeed in l	Both Direction	
H Series				Ra	apid Revers	
M od						
IVI OG						
45.0.000.4	6,000 lb	69 fpm	4,091 lb	101 fpm	1/2" -152 ft	
VI5-3-230-1	26.7kN	21m/m in	18.2 kN	31m/min	46m	
VI8-3-30-1	8,500 lb	116fpm	5,79 5 lb	170 fpm	1/2" -152 ft	
H8-3-30-1	37.8kN	35m/m in	25.8kN	52 m/m in	46m	
VI8A-3-30-1	7,000 lb	135 fpm	4,773 lb	19 9 fpm	1/2" -152 ft	
H8A-3-30-1	31.1 kN	41m/m in	2 1.2kN	61m/m in	46m	
M8B-3-30-1	3,790 lb	2 49 fpm	2,584lb	366fpm	1/2" -152 ft	
H8B-3-30-1	16.9 kN	76m / m in	11.5 kN	111m/m in	46m	
V112-3-97-1	12,121 lb	104fp m	7,143 lb	176fpm	5/8" -222 ft	
H12-3-97-1	53 9kN	32m/min	31.8kN	54m/m in	68m	
M12B-3-97-1	6,120lb	205 fpm	3 ,606lb	348fpm	5/8"-222 ft	
H12B-3-97-1	27.2 kN	63m / m in	16.0kN	106m/m in	52 m	
M18-3-101-1	18,000 lb	122 fpm	11,288lb	19 5fpm	3/4"-170 ft	
H18-3-101-1	80.1kN	37m /m in	50.2 kN	59 m/m in	43 m	
W25-7-86-1	25,000 lb	140 fpm	16,860lb	207fpm	7/8"-140ft	
H25-7-86-1	111.2 kN	43m/m in	75.0 kN	63m / m in	43 m	
M25B-7-86-1	12,69 8lb	273 fpm	8,564lb	405 fpm	7/8" -140 ft	
H25B-7-86-1	56.5 kN	83m /m in	381kN	124m/m in	43 m	
VI50-7-86-1	50,000 lb	69 fpm	3 3,889 lb	102 fp m	1 1/4"-177 ft	
150-7-86-1	222.4kN	21 m/min	150.7kN	31 m / m in	54m	
M75-7-191-1	75,000 lb	72 fpm	41748 lb	129 fpm	1 1/8" -727 ft	
H75-7-191-1	333.3kN	22 m / m in	185.6kN	39 m/m in	222m	

<sup>\*</sup>For HS eries reversing speeds, multiply the line speeds listed by a

HL Serie	es				Ra	pid Rever	se & 2	-Speed F	orward
	LinePul		LinePul		LinePul	Line Speed	LinePul	Line Speed	
HL25-786-1	25,000 lb	140 fpm	16,860 lb	20 7fpm	5,357 lb	651fpm	3,613lb	965fpm	7/8"-140ft
HLZ 3-/-86-I	111.2kN	43m / m in	75.0kN	63 m /m in	23.8kN	198m /m in	16.1kN	294m/m in	43m




- Control Room Operator Console
  - Accessible by Stairs. Where the winch controls and pressure gauges will be mounted







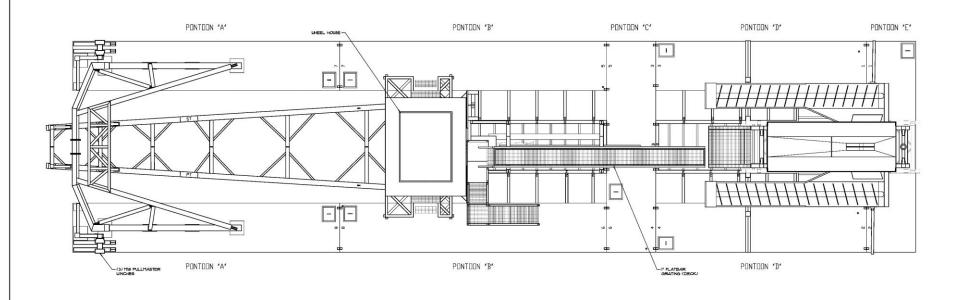


#### MINING DREDGE PLAN VIEW



MINING DREDGE PLAN VIEW		SH	HEET S-1
MINATURA NEVADA, CORP.	SCALE: 1/4" = 1'-0"		
ENGINEERING & DESIGN: N/A	DRAWN BY: C.G.I.		DATE: 02-02-10



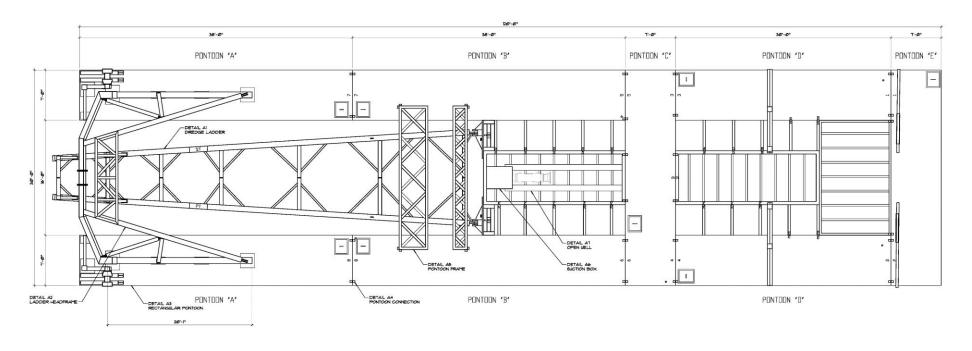


#### MINING DREDGE DIMENSIONED PLAN VIEW



MINING DREDGE DIMENSIONED PL	SH	SHEET S-2		
MINATURA NEVADA, CORP.	SCALE: 1/4" = 1'-0"			
ENGINEERING & DESIGN: N/A	DRAWN BY: C.G.I.		DATE: 02-02-10	



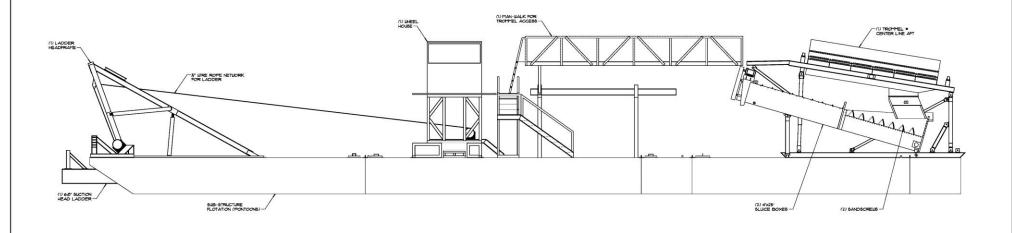


#### MINING DREDGE PORT ELEVATION




MINING DREDGE PORT ELEVATION		SH	IEET S-3
MINATURA NEVADA, CORP.	SCALE: 1/4" = 1'-0"		o
ENGINEERING & DESIGN: N/A	DRAWN BY: C.G.I.		DATE: 02-02-10



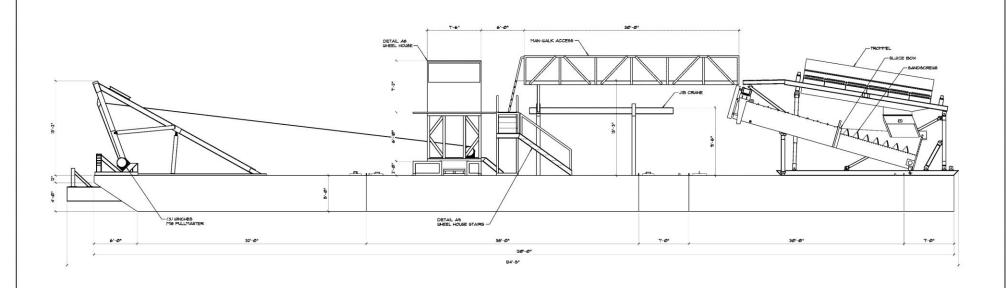



#### MINING DREDGE DIMENSIONED PORT ELEVATION

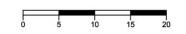


MINING DREDGE DIMENSIONED F	PORT ELEVATION	SH	HEET S-4
MINATURA NEVADA, CORP.	SCALE: 1/4" = 1'-0"		12.5
ENGINEERING & DESIGN: N/A	DRAWN BY: C.G.I.		DATE: 02-02-10



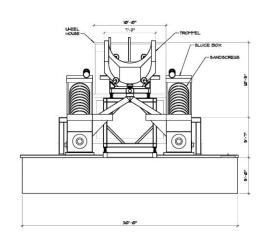

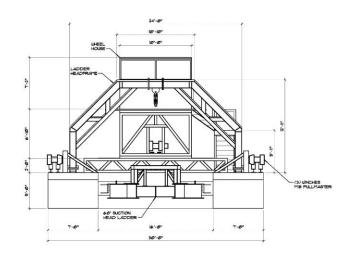


#### MINING DREDGE FRONT AND REAR ELEVATIONS

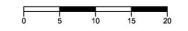



	MINING DREDGE FRONT AND REAL	RELEVATIONS	SH	HEET S-5
ž	MINATURA NEVADA, CORP.	SCALE: 1/4" = 1'-0"		
	ENGINEERING & DESIGN: N/A	DRAWN BY: C.G.I.		DATE: 02-02-10



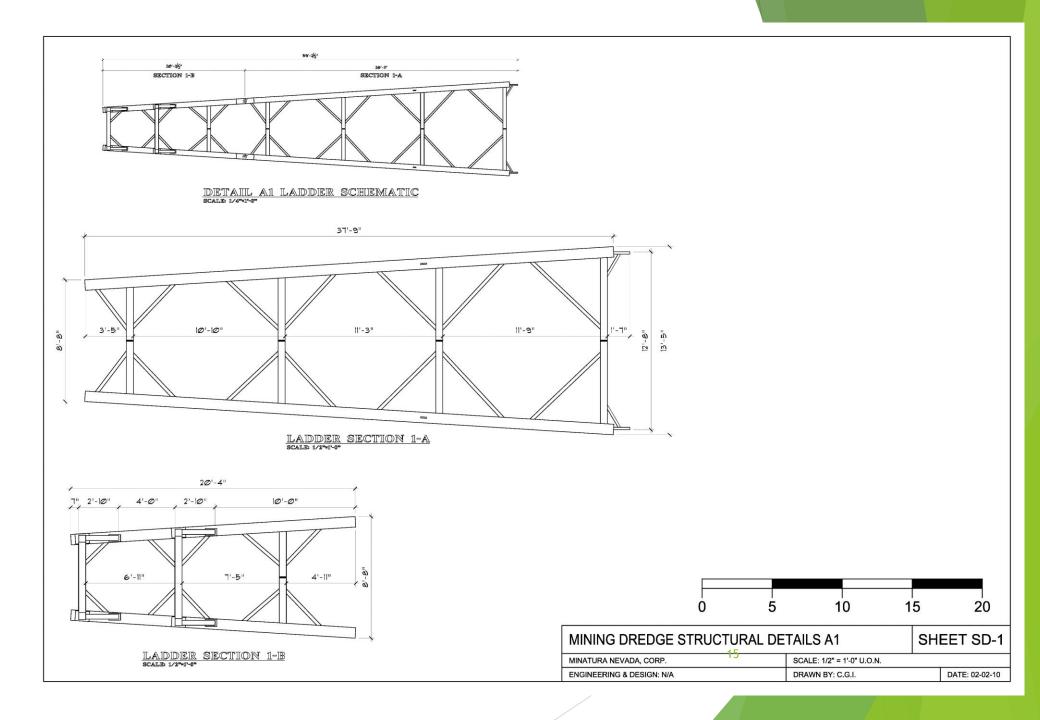




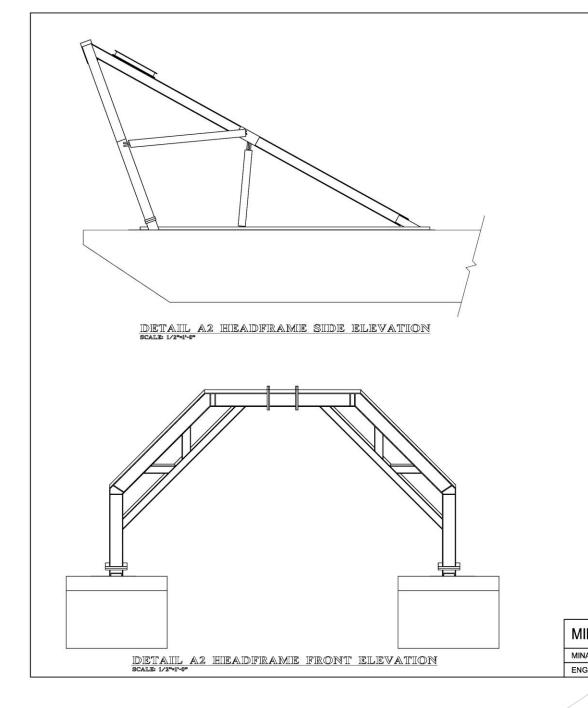


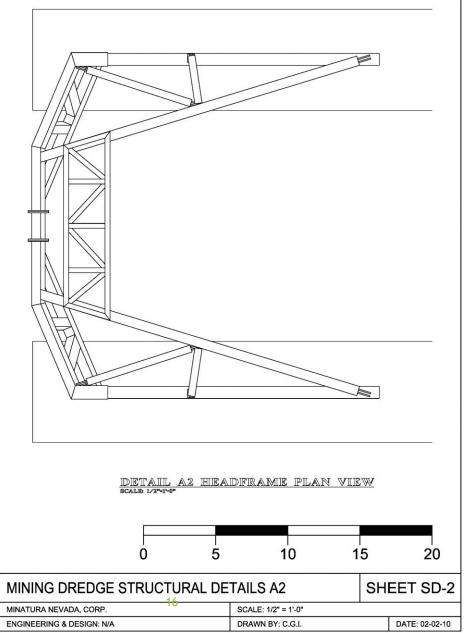





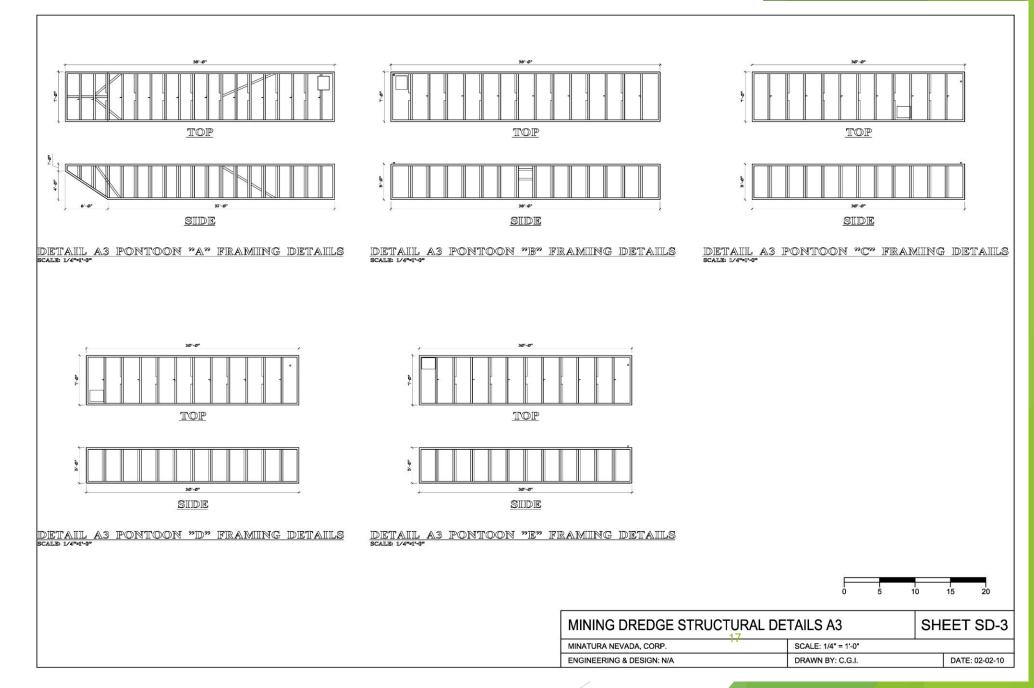



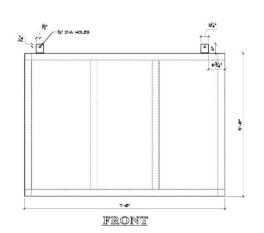


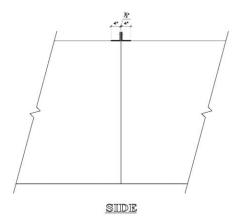


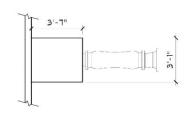


DETAIL A4 PONTOON CONNECTION SCALE 1"41-9"

DETAIL A6 SUCTION BOX

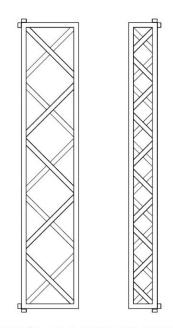

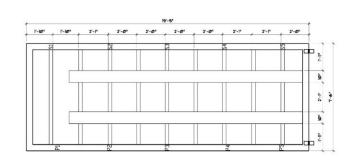


DETAIL A7 OPEN WELL

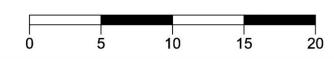

MINING DREDGE STRUCTURAL DE	TAILS A4 - A7	SH	EET SD-4
MINATURA NEVADA, CORP.	SCALE: 1/2" = 1'-0"		
ENGINEERING & DESIGN: N/A	DRAWN BY: C.G.I.		DATE: 02-02-10

DETAIL AS PONTOON FRAME SCALE: 1/2"-1"-9"



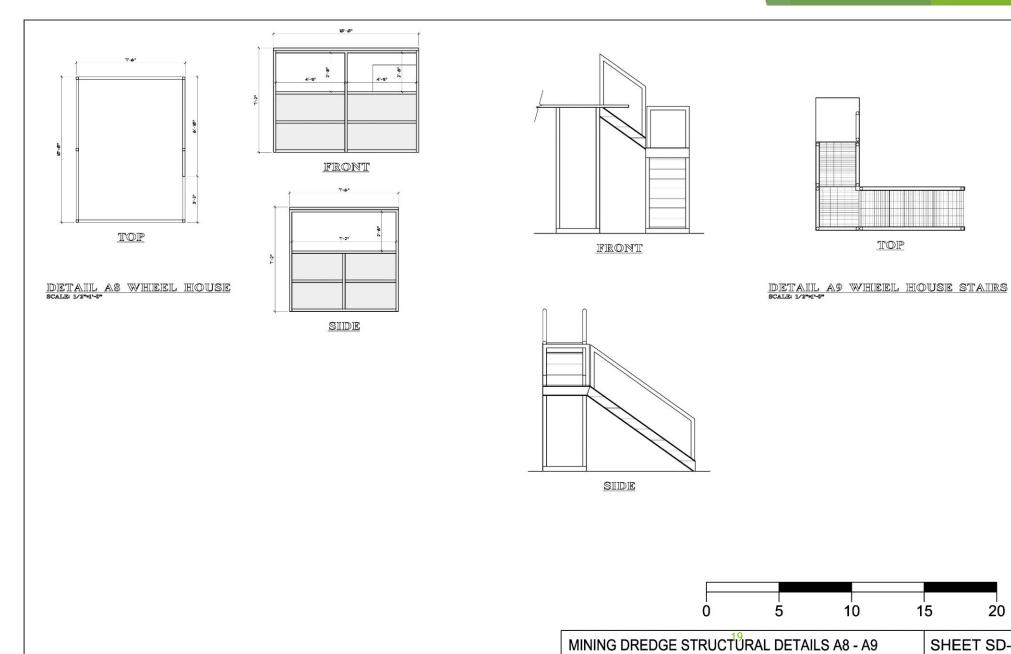

20

SHEET SD-5

DATE: 02-02-10

SCALE: 1/2" = 1'-0"


DRAWN BY: C.G.I.

MINATURA NEVADA, CORP.

ENGINEERING & DESIGN: N/A



		Revisions	
Zone	Rev	Description	Date
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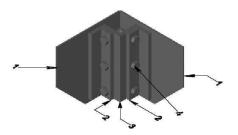


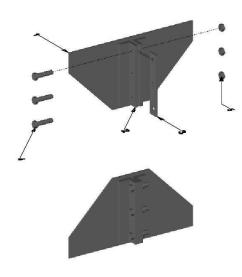- 1) 3/8" SUPPORT PLATE 2) BOLT BRACKET 3) SPACER PLATE 4) 1 1/4" BOLT

Unless Otherwise		Name	Date			
Dimensions in Inches	Drawn			YU	BA INDUSTRIES	COMPANY
Tolerances: Fractional ± Angular: Mach ± Bend	Checked					
Two Place Decimal	ENG Appr.			KI	NG DREDGE P	ROJECT
				HUL	L BOLT ASSEMBLY	
	QA					
	Comme		-			
Material	CAD Generated Drawing			Size	Drawing	Rev
Finish					YDC-HB1	
Do NotScale				Scale	NONE CAS FILE	1



		Revisions	
Zone	Rev	Des cription	Date






- 1) 3/8" SUPPORT PLATE 2) BOLT BRACKET 3) CORNER SPACER

Unless Otherwise		Name	Date			
Dimensions in Inches	Drawn			YUE	BA Industries	
Tolerances: Fractional ± Angular: Mach ± Bend	Checked					
Two Place Decimal	ENG Appr.	0	×		<b>REDGE PROJE</b> L BOLT ASSEMBLY	ECT
	QA	8		HUL	L BOLT ASSEMBLY	
Material	Comme  CAD Generated Drawing			Size	Drawing	Rev
Finish					YDC-HB2	
Do NotScale				Scale	NONE CADFILE	1



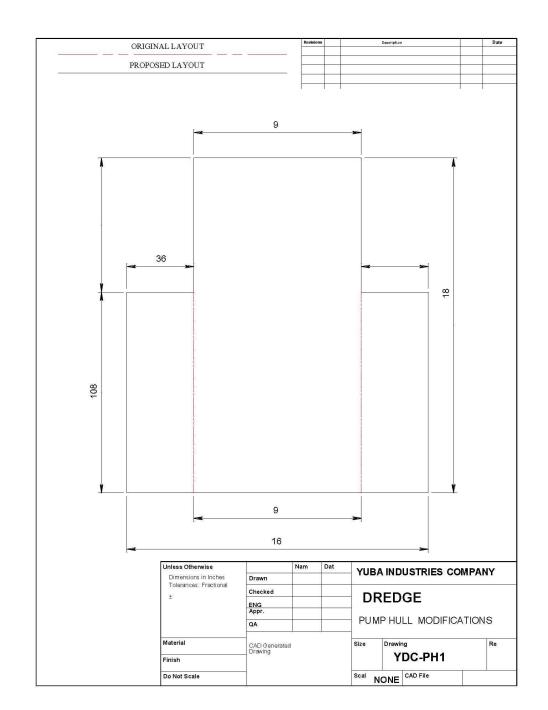



# Scope of Supply (Included & What's Needed to Complete)

Dredge Project	Component	Description	Cost
Dredge	Haul & Control Room	A.M. King Ellicot Style Suction Dredge (Unused)	\$ 325,000.00
Cutter Head Pump	Warman 14X16	9,000 GPM 1,000' TB (Used)	Included
Winches	Winches	Pullman Winches (4) (Used)	Included
Components To Complete Dre	edge		
Hull Bolts	Hull mounting bolts	1 1/4 grade 8, nuts, flats	To Be Costed in Mexico
Winches	Head line winch	Pull Master H18-3	To Be Costed in Mexico
Winches	Ladder hoist	Pull Master H18-3	To Be Costed in Mexico
Winches	Wire Rope	3/4" X 5000'	To Be Costed in Mexico
Cutter Head	Cutter head size	38" 6 Blade	To Be Costed in Mexico
Cutter Head	Cutter head drive	CD38	To Be Costed in Mexico
Cutter Head	Suction mouth piece	16" Suction	To Be Costed in Mexico
Cutter Head	Head plate	16" head plate	To Be Costed in Mexico
Hydraulic System	Cutter drive pump	180 CC variable displacement	To Be Costed in Mexico
Hydraulic System	winch drive pump	3 stage pump	To Be Costed in Mexico
Hydraulic System	Pilot system pump	Pilot system	To Be Costed in Mexico
Hydraulic System	Winch control pilot valves	directional control joy stick	To Be Costed in Mexico
Hydraulic System	Pilot control valves	pilot controlled flow valves	To Be Costed in Mexico
Hydraulic System	Reservoir #1	100 gallon reservoir	To Be Costed in Mexico
Hydraulic System	Reservoir #2	200 gallon reservoir	To Be Costed in Mexico
Hydraulic System	Misc. Misc. valves, filters, gauges, strainer	s ect	To Be Costed in Mexico
Hydraulic System	Hoses and Fittings Hoses, Fitting, Tubes, C	lamps, Etc.	To Be Costed in Mexico
Cutter Head Pump Components	Warman 14X16	Liners ICS wear group	To Be Costed in Mexico
Cutter Head Pump Components	Suction hose	16" x 60' (15' sections)	To Be Costed in Mexico
Cutter Head Pump Components	Discharge Drisco Pipe w/ floats		To Be Costed in Mexico
Electrical	Generator	TBD	To Be Costed in Mexico
Control room	Windows	1/4" Plate Glass glue set	To Be Costed in Mexico
Control room	Door		To Be Costed in Mexico
Control room	Control Panel		To Be Costed in Mexico
Control room	Lights/electrical		To Be Costed in Mexico
			T@Be Costed in Mexico
Steel	Pump hull expansion	Plate, angel iron, channel, tubing	To Be Costed in Mexico
Steel	Stairs and decking	channel, expanded metal, misc.	To Be Costed in Mexico

A.M. King Provided

Source By
Customer By
Vendors Of Their
Choice



Example Quotes For Work to Complete (need to be updated to 2020

pricing)



DREDGING SUPPLY COMPANY, INC. 156AIRPORT ROAD RESERVE, LA 70084 (985) 479-1355 Quote

Page 1 of 1

Order Number: 0224813 Order Date: 10/9/2014

Salesperson: PART Customer Number: NONCUS

SoldTo: YUBA INDUSTRIES ShipTio: YUBA DREDGING

loh#

Confirm To: TONY MASSEY

Customer P.O.	Ship VIA		F.O.B.	Terms NET 30 TERMS		
Item Number	Unit	Ordered	Shipped	Back Order	Price	Amount
8500016878 CUTTER HEAD	EACH	1.000	0.000	0.000	22,135.000	22,135.00
	43.00" ID CUTTE	R HEAD, 6 BLADE,	WITHSERRATED ED	GES		
2800014498	EACH	1.000	0.000	0.000	48,246.000	48,246.00
CUTTER DRIVE	CD63 CUTTER D	RIVE WITH HYDRA	ULIC MOTOR AND GE	EARBOX		
/MISCI	EACH	1.000	0.000	0.000	1,979.000	1,979.00
	SUCTION MOU	THPIECE				
MISCI	EACH	1.000	0.000	0.000	1,770.500	1,770.50

4 WEEK DELIVERY ON ALL ITEMS

HEADPLATE

 NetOrder:
 74,130.50

 Less Discount:
 0.00

 Freight:
 0.00

 Sales Tax:
 0.00

74,130.50

Approval Signature:


Order Total:

TERMS AND CONDITIONS: The prices listed above are good for 30 days and do not include any applicable sales/use tax All items quoted are subject to prior sale or commitment All matters arising out of or relating to this sale shall be governed by the laws of the State of Louisiana (exclusive of conflict of laws principles).







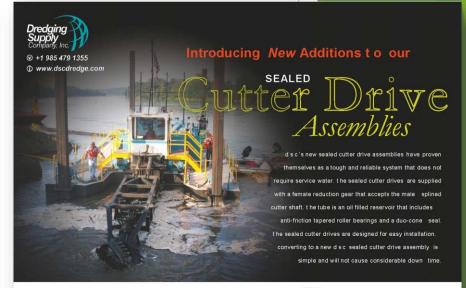



	c d 25	cd30	cd38			cd71		
	32,629 in-lbs	88,414 in-lbs	144,933 in-lbs	229,433 in-lbs	407,784 in-lbs	679,073 in-lbs	1,054,120 in-lbs	2,400,195 in-lbs
	3,685 N-m	9,986 N-m	16,368 N-m	25,912 N-m	46,056 N-m	76,695 N-m	119,053 N-m	271, 081 N-m
rated power	25 hp	60 hp	90 hp	130 hp	200 hp	300 hp	400 hp	800 hp
	19 kW	45 kW	67 kW	97 kW	149 kW	224 kW	298 kW	597 kW
rated speed	48 RPM	42 RPM	38 RPM	35 RPM	31 RPM	27 RPM	24 RPM	21 RPM
rated flow	20 GPM	36 GPM	54 GPM	60 GPM	84 GPM	123 GPM	163 GPM	297 GPM
	78 l/min	138 I/min	204 l/min	228 Vmin 24	318 l/min	468 I/min	618 Vmin	1122 Vmin
rated pressure	2400 psi	3250 psi	3250 psi	4230 psi	4680 psi	4790 psi	4480 psi	4930 psi
	165 bar	224 bar	224 bar	292 bar	323 bar	330 bar	309 bar	340 bar



# Example Quotes For Work to Complete (need to be updated to 2020 pricing)

#### **QUOTATION**

DATE: 10/22/2014 QUOTE #: H14.606 YD HYDRA WORKS, LLC 37505 BROWNS VILLAGE RD. SLIDELL, LA 70460 STE. B

YUBA INDUSTRIES Marysville, Ca.

PH: 985-645-8726 FX: 985-645-8678

ATTN: John

qeneQhydraworksllc.com

Ref: Hydraulic equipment for dredge

ITEM NO UNIT PRICE TOTAL Cutter Drivecomponents 1 Sundstrand 180 CC variable volume hydraulic pump - closed loop, pilot operated controlled 1 Parker IL2 suction filter 1 Parker 80 CN charge filter 1 900116-M4S friction holdjoy stick 1 100 Gallon capacity hydraulic oil reservoir c/w filler breather, sight-temp guage, float switch, 1 XRJB-LCN-A61S cross port reliefvalve Winch operation components 1 P76 triple stage hyd. pump 75 gpm/ 35 gpm/ 1 A10V010 Pilot pump 1 V90-M-M-HRO directional valve- Ladder and head line winch operation 1 PCL402-04 Remote joy stick control- Ladder and head linewinch 2 DVA35-M-M-HRO directional control- positioning Winch operation 2 PCL402-04 Remote joy stick control- positioning winch operation 1 RF210-10Q return line filter 1 AOC-50-50-2-3PH Oil cooler

GENE BOURGEOIS

DATE: 10/22/2014 QUOTE#: H14.606YD HYDRA WORKS, PLC 37505 BROWNSVILLAGE RO. SLIDELL, LA 70460 STE. B

YUBA INDUSTRIES Marysville, Ca,

PH: 985-645-8726 FX: 985-645-8678

gene. hydraworksllc.com

Hydraulic equipment for dredge

ITEM NO.	QTY.	DESCRIPTION	UNIT PRICE	TOTAL
		Continue winch operation components		
1	1	IFP-092 suction strainer		
1		IFP-055 suction strainer		
1		IFP-016 suction strainer		
1	2	LEFC 165524LM Electric flow control - variable		
70		speedc control for positioning winches		
19	2	EC20200 Remote electrical variable remote control operating item 18		
20	1	200 Gallon capacity hydraulic reservoir c/w filler breather, sight-tempguage, float switch,		
		suction strainer installed, and paint		
21	4	PR101 Pressure reducing valves		
		Note: Electric motors, couplings, piping, hose, and fitting to be supplied by YUBA All the listed equipment to be installed by YUBA. This quote excludes any taxes. Prices subject to change with any alterations.		
		Terms: 50% deposit wit order, balance upon shipment		
		Fob: Slidell, La.70460		
		Delivery: 0 weeks, after receipt of deposit		\$53,000.0
			Tax	\$33,000.0

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